


9.8 10 11 12 13 14 14.5 15 16 16.5 17 18

3'-6" 6'-6" 10'-0" 10'-0" 10'-0" 3'-4" 6'-2" 21'-0" 6'-2" 3'-4" 12'-0"

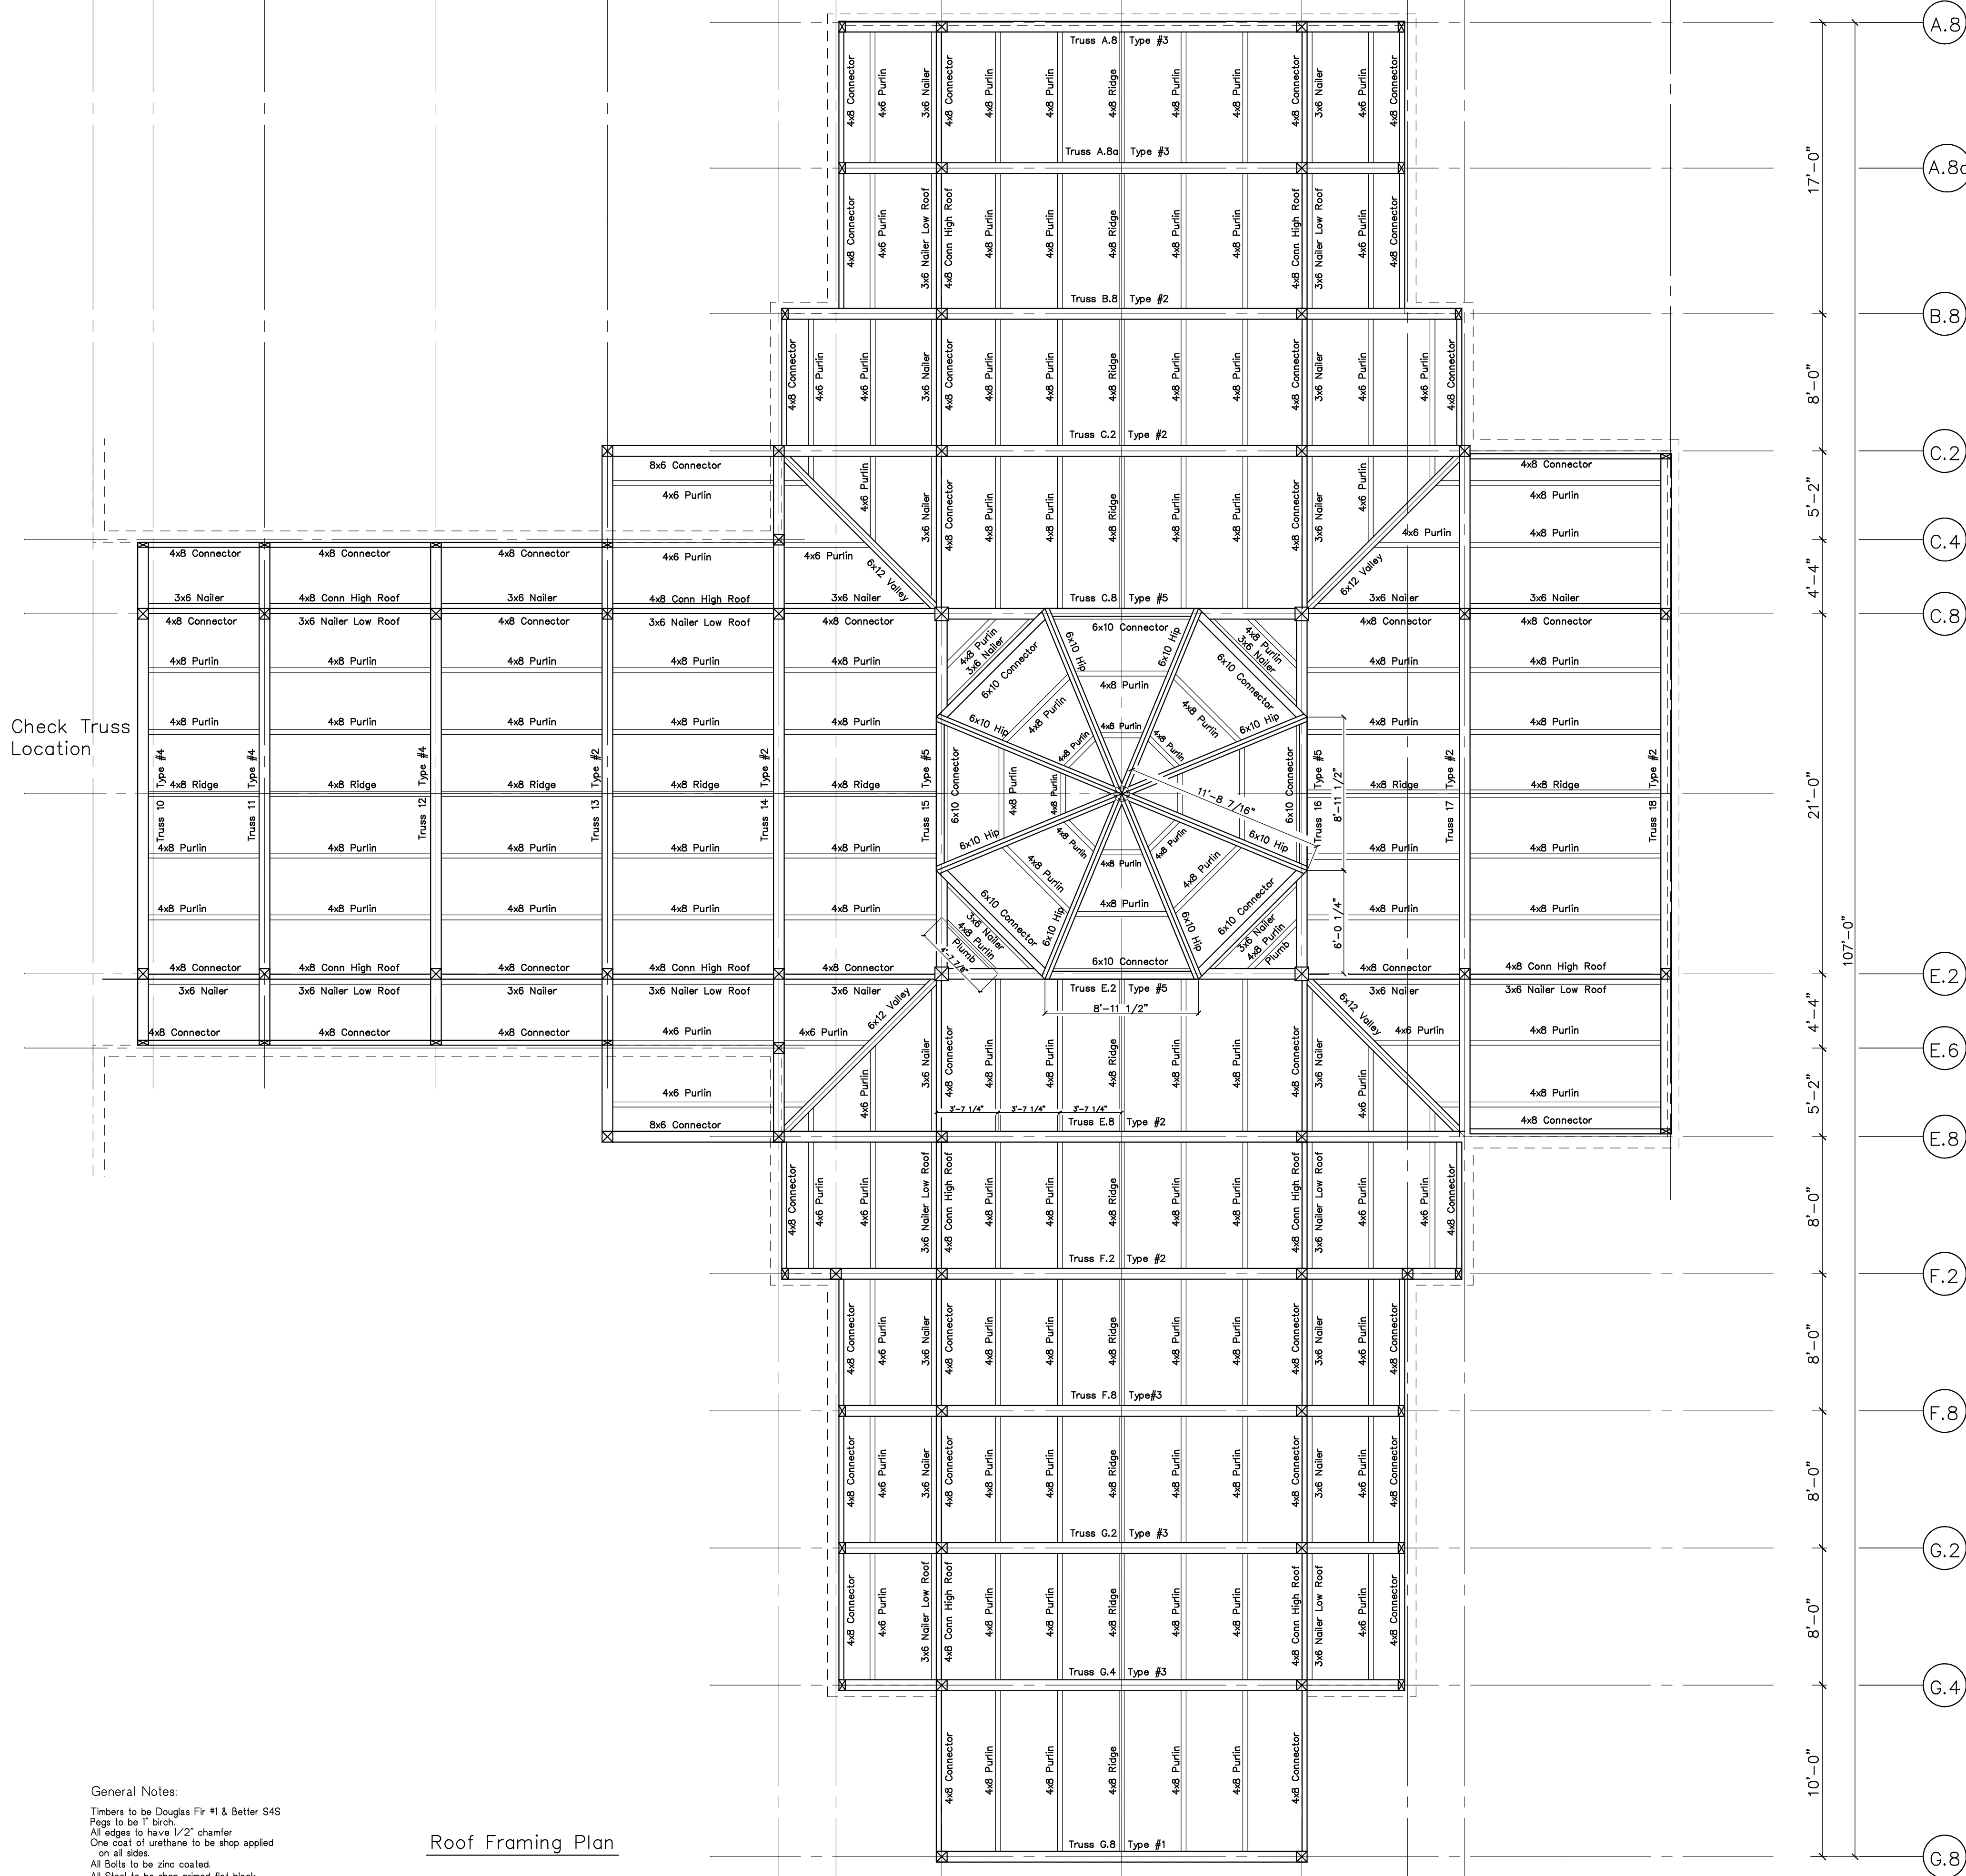




Check Truss Location

General Notes:
Timbers to be Douglas Fir #1 & Better S4S
Pigs to be T Birch
All edges to have 1/2" chamfer
One coat of urethane to be shop applied on all sides
All Bolts to be zinc coated.
All Steel to be shop primed flat black.

Roof Framing Plan

A.8
A.8c
B.8
C.2
C.4
C.8
E.2
E.6
E.8
F.2
F.8
G.2
G.4
G.8

17'-0"
8'-0"
5'-2"
4'-4"
21'-0"
107'-0"
4'-4"
5'-2"
8'-0"
8'-0"
8'-0"
8'-0"
8'-0"
8'-0"

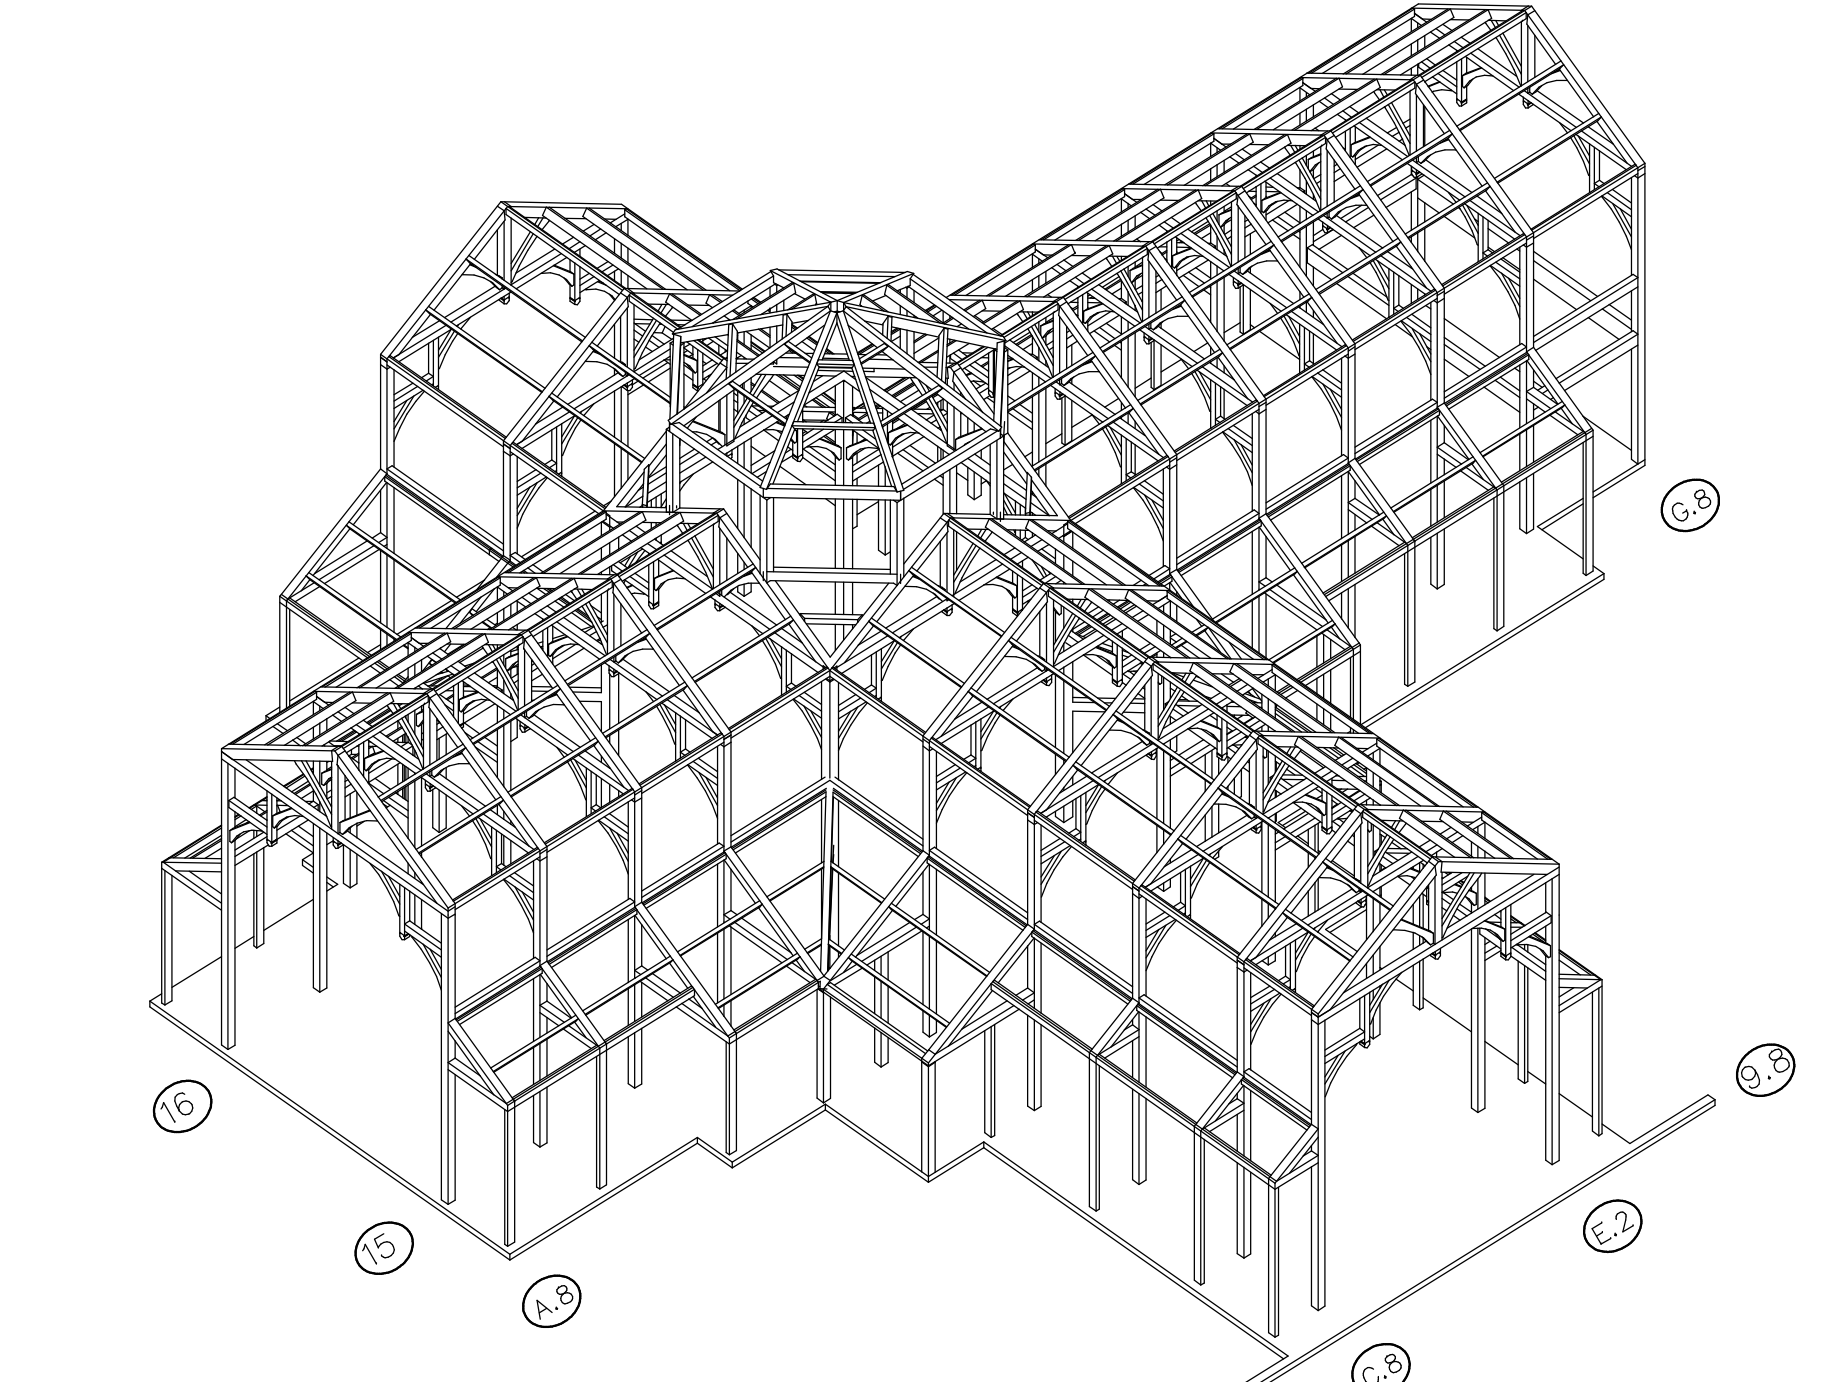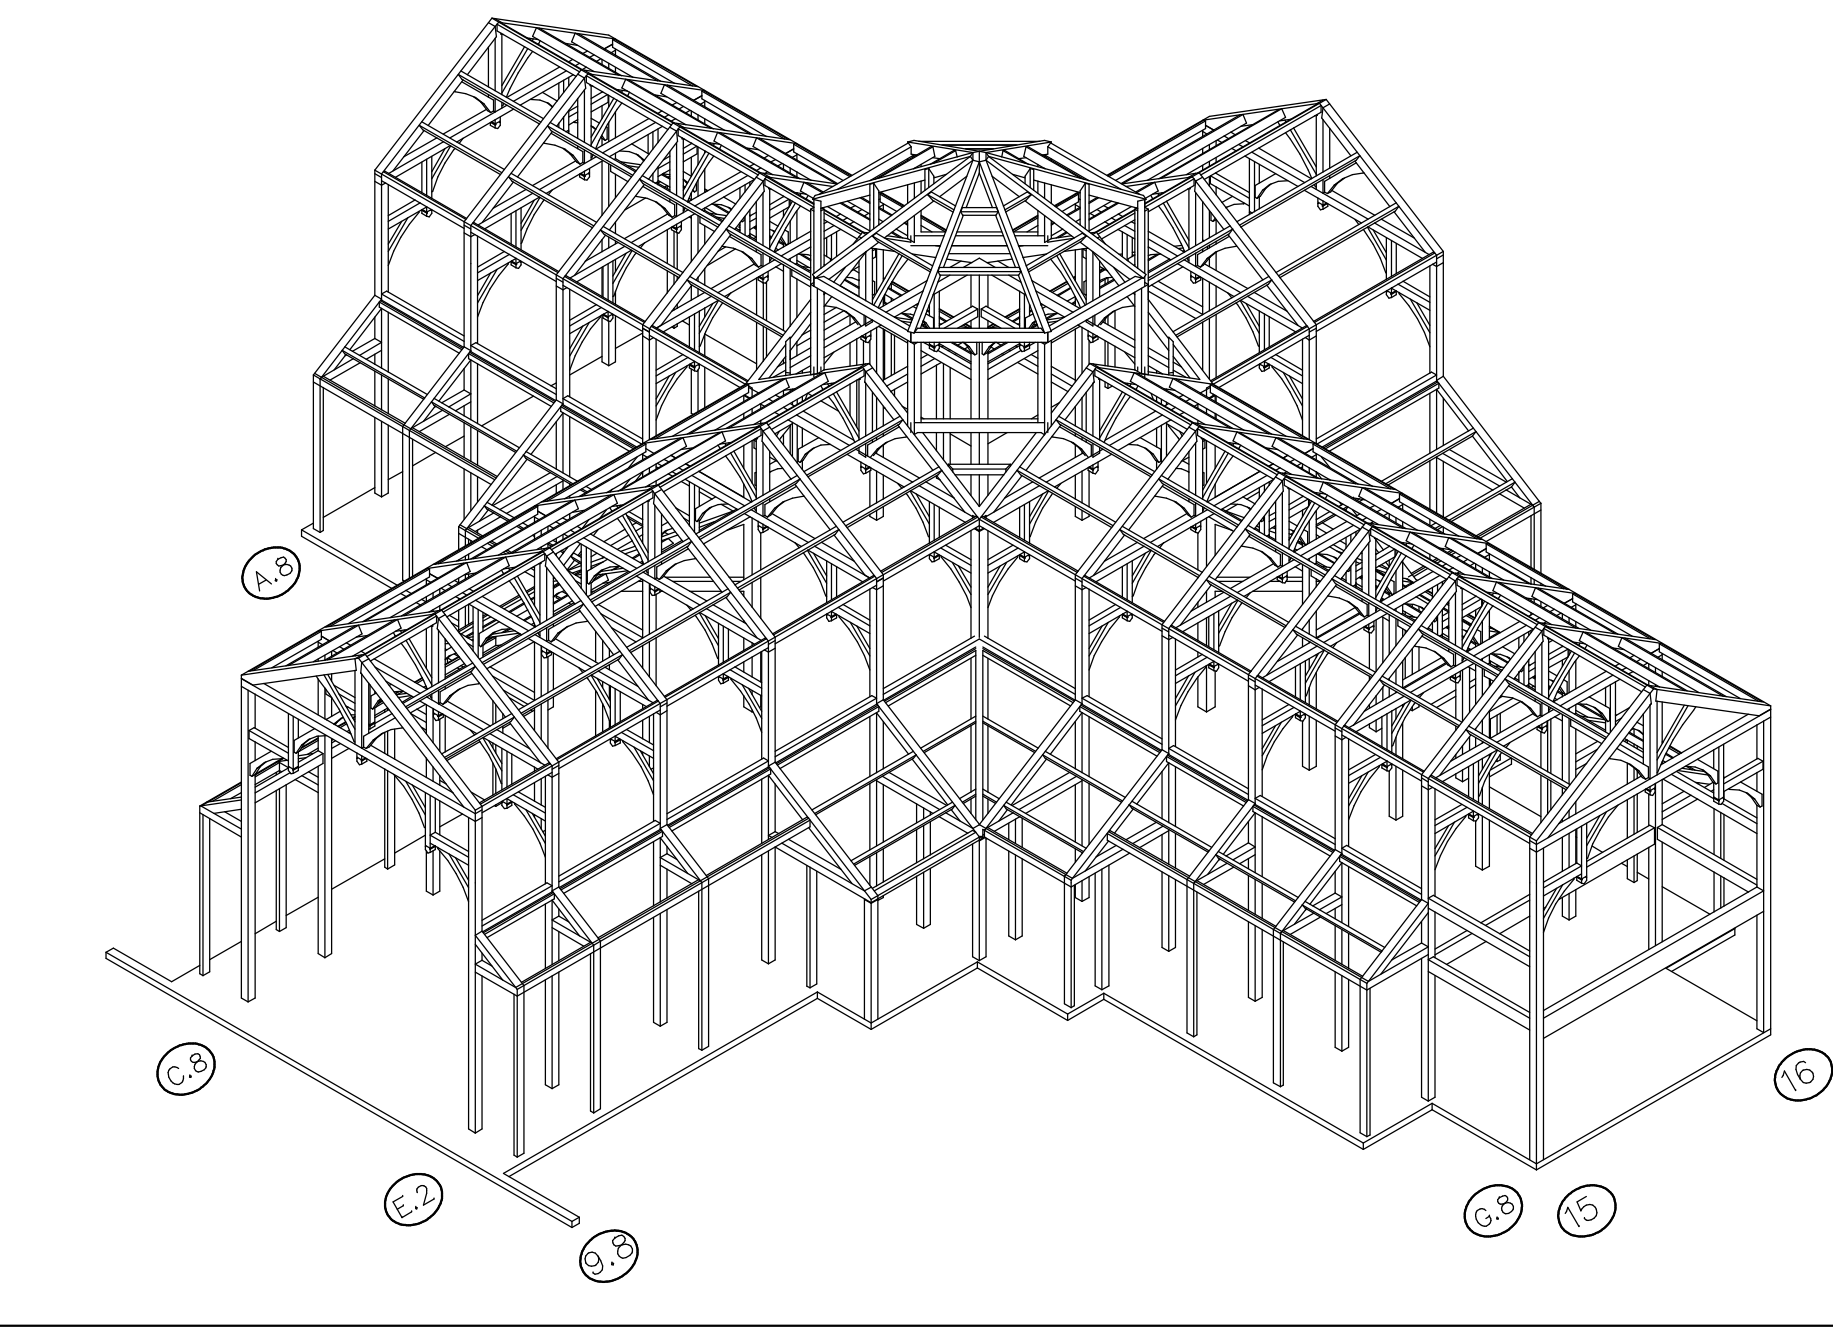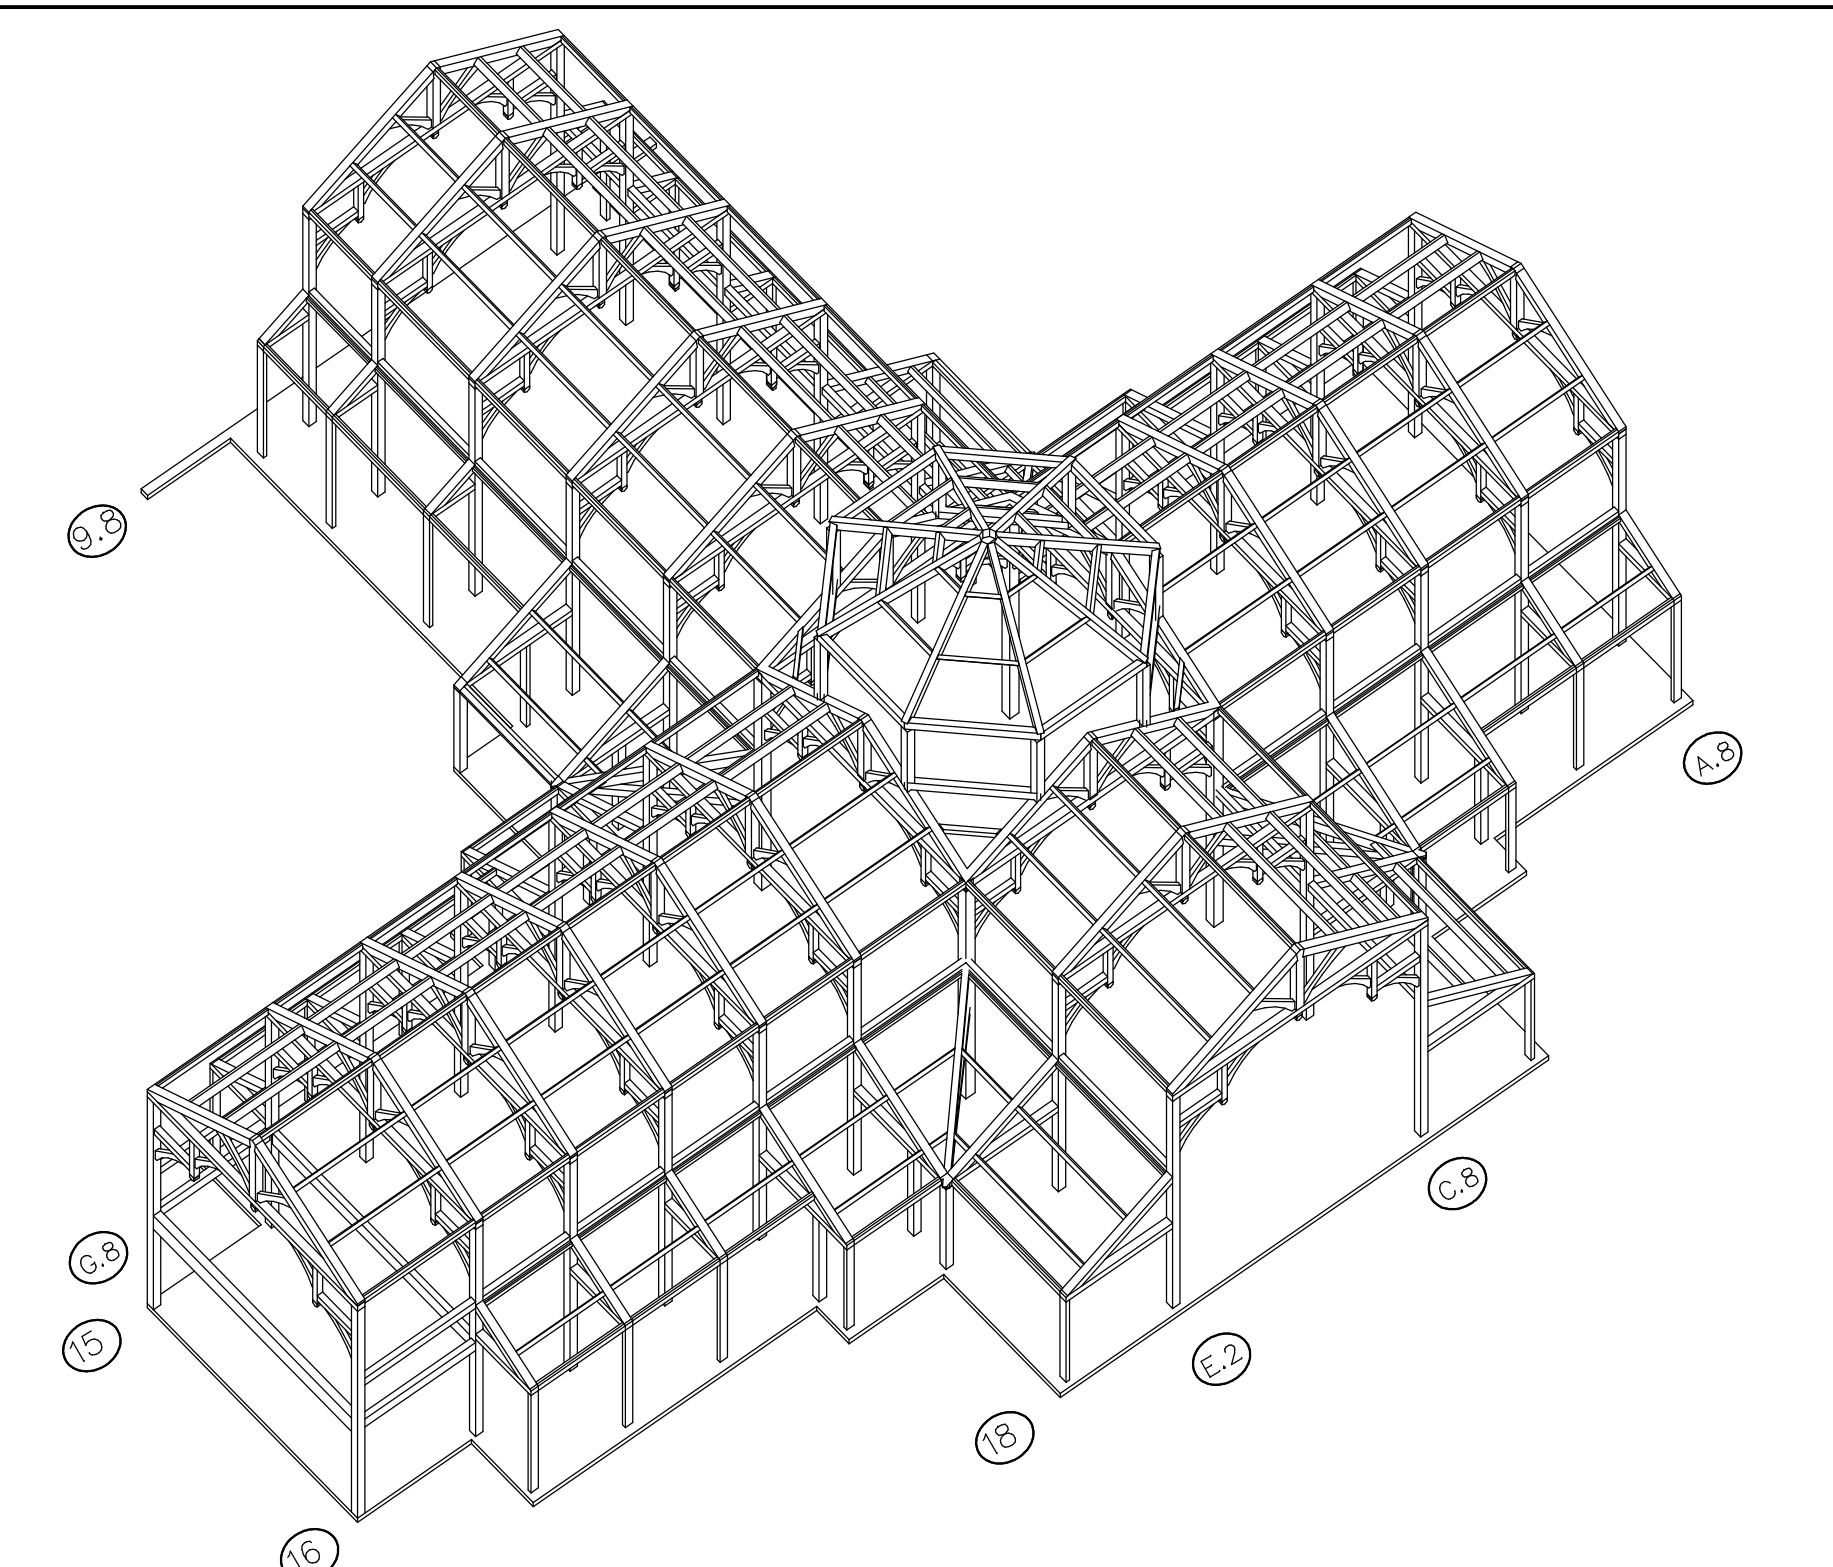

REVISIONS	BY
1/14/03	



SHOP DRAWINGS
Roof Framing

Engineering Ventures
208 Flynn Avenue
Burlington, VT 05401
802-863-6225
802-863-6306 Fax

The Bethlehem Monastery
of Poor Clares
PROJECT:
Timber Frame
Barhamsville, VA

DRAWN : D.F.
CHECKED :
DATE : 12/12/02
SCALE : 3/16"=1'-0"
JOB NO. :
SHEET

F-2
OF SHEETS